



CITY OF CAMPBELL
Community Development Department

September 29, 2017

NOTICE OF ADMINISTRATIVE SITE AND ARCHITECTURAL REVIEW


Notice is hereby given that the Planning Division of the Community Development Department of the City of Campbell has received an application for an Administrative Site and Architectural Review Permit for the following project proposal:

File No.: PLN2017-217
Applicant: Joseph Xu
Project Address: 1875 S. Bascom Ave., Ste. 440 (The Pruneyard)
Property Owner: CFEP Pruneyard, LLC
Zoning District: R-1-9 (Single Family Residential) / San Tomas Area Neighborhood Plan
General Plan: Low Density Residential
Project Description: To allow an approximately 1,121 square-foot one-story rear addition to an existing one-story single-family residence .

This project will be decided by the Community Development Director and you have the opportunity to provide comment prior to the Director's decision. The ten-day comment period for this application begins on October 3, 2017 and ends on October 13, 2017. Any comments regarding this application must be submitted in writing (including email) to the Planning Division before 5:00 p.m. on **October 13, 2017**. The Director will then consider all comments submitted within this time period prior to a decision. No additional notice will be provided. Please contact the project planner in a timely manner to determine what decision was reached.

Decisions by the Community Development Director are final in 10 calendar days following the date of approval, unless an appeal is received in writing at the City of Campbell Community Development Department, 70 N. First Street, Campbell, prior to the end of the appeal period. A written appeal must be accompanied with the required \$750 appeal filing fee. Plans and architectural drawings may be viewed at the Planning Division office during normal business hours (8:00 AM – 5:00 PM) and on the City's 'Public Notices' web page (<http://www.cityofcampbell.com/501/Public-Notices>) under 'Administrative Decisions'. Questions or comments regarding this application may be addressed to Stephen Rose, Associate Planner, in the Community Development Department, at (408) 866-2142 or by email stephenr@cityofcampbell.com.

Project Location Map

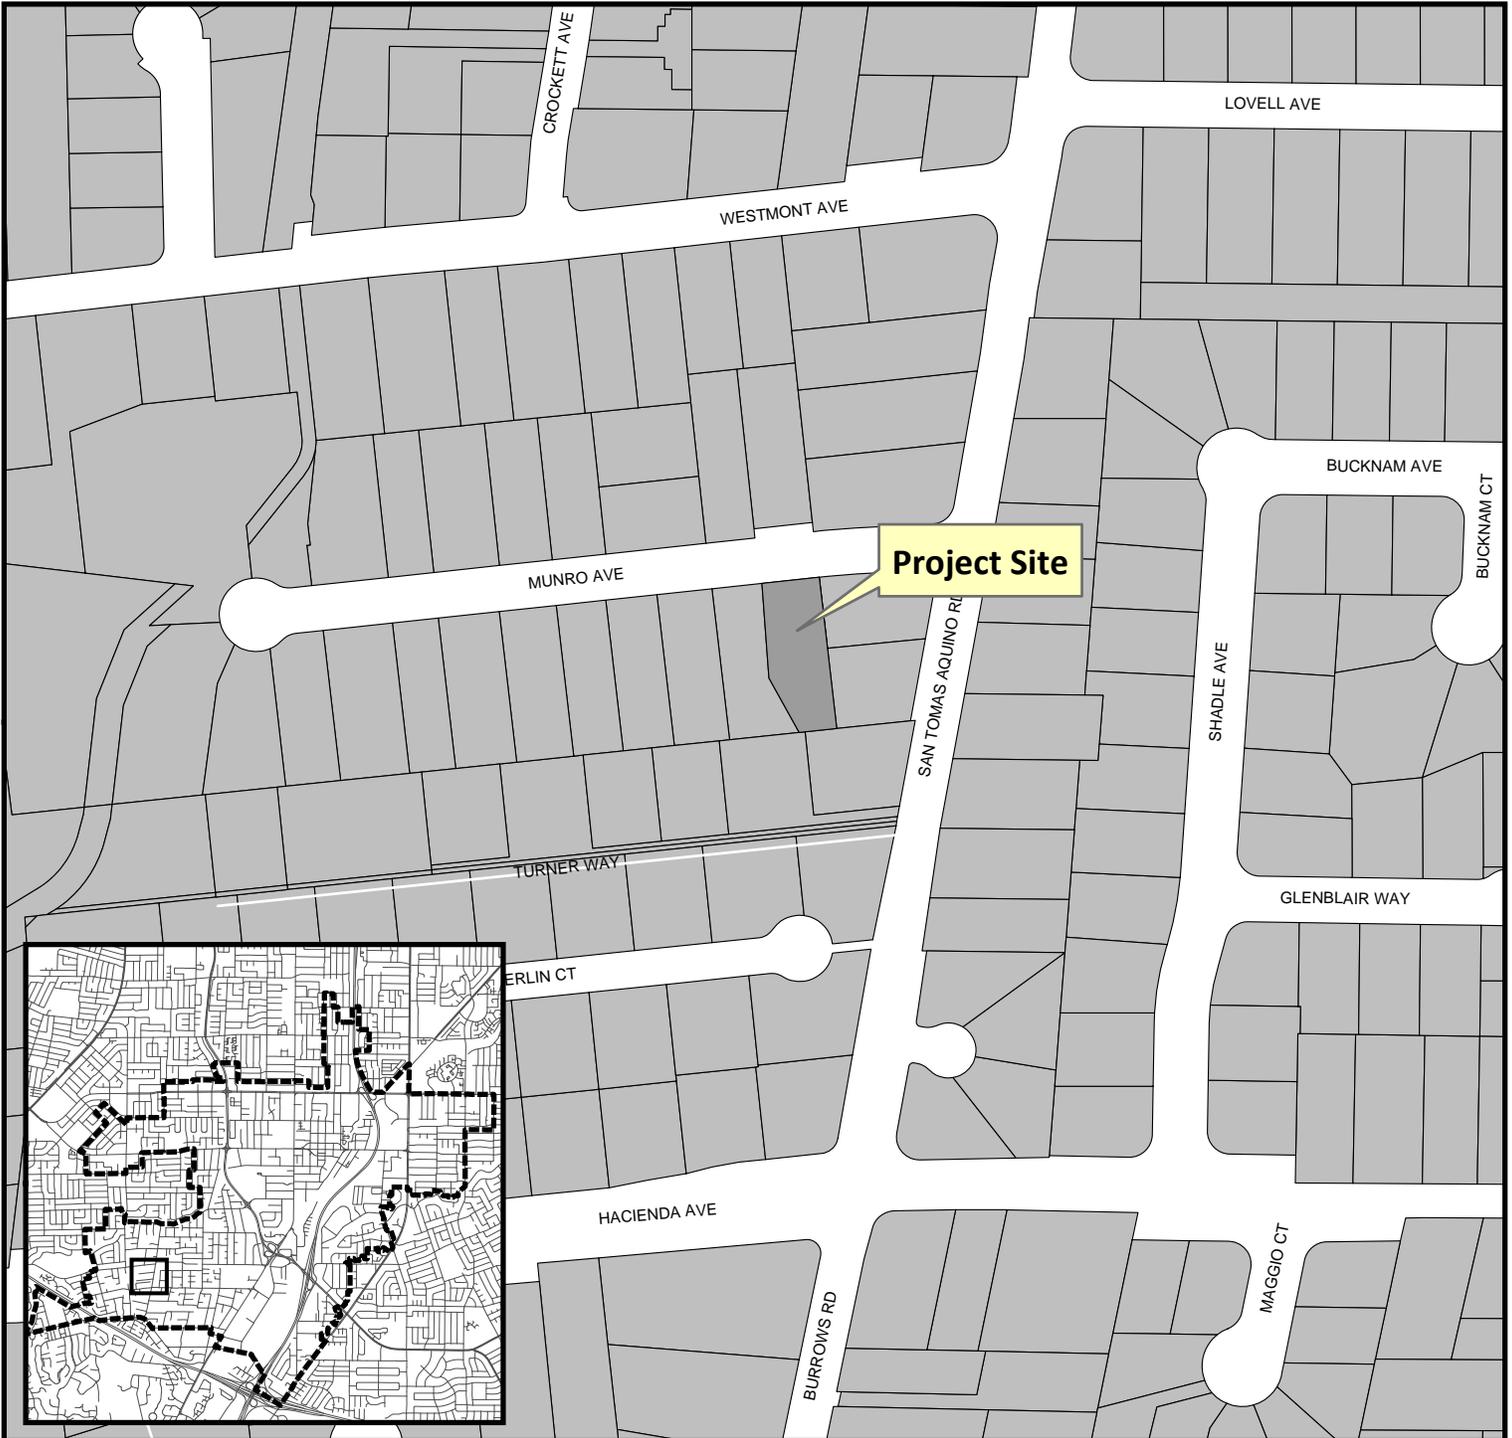


Project Location: 1286 Munro

Application Type: Admin. Site and Arch.

Planning File No.: PLN2017-217

Description: To allow for a 1,121 square foot addition to an existing 932 square foot single-story single family residence with a 371 square foot detached garage.

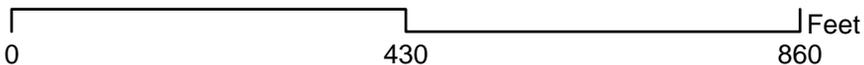

Community Development Department
Planning Division

WALL LEGEND

- INDICATES NEW WALL
- INDICATES EXISTING WALL TO REMAIN
- INDICATES EXISTING WALL TO BE REMOVED

ELECTRICAL LEGEND


- 110V DUPLEX OUTLET
- 240V OUTLET
- WATERPROOF DUPLEX OUTLET AND GFI
- GROUND FAULT INTERRUPTER OUTLET
- CEILING MOUNTED LIGHT FIXTURE
- HIGH EFFICACY LIGHT FIXTURE
- WALL MOUNTED LIGHT FIXTURE
- PHOTOELECTRIC SMOKE ALARM
- DUAL SENSOR (PHOTOELECTRIC/IONIZATION) SMOKE ALARM
- SWITCH
- MANUAL ON OCCUPANCY SENSOR
- 3-WAY SWITCH
- DIMMER SWITCH
- EXHAUST FAN
- TELEPHONE
- CARBON MONOXIDE (CO) ALARM

ATTIC FURNACE NOTES:

1. PROVIDE 24" WIDE PLATFORM PATH FROM ACCESS OPENING TO FURNACE WITH A RECEPTACLE AT THE FURNACE AND A LIGHT SWITCHED FROM ACCESS OPENING.
2. FURNACE IN ATTIC SHALL BE ACCESSIBLE FOR INSPECTION, SERVICES, REPAIR AND REPLACEMENT WITHOUT REMOVING PERMANENT CONSTRUCTION NOT LESS THAN 30" IN DEPTH, WIDTH AND HEIGHT OF WORKING SPACE SHALL BE PROVIDED FOR SERVICING. (CMC 304.0)
3. PROVIDE AN ADDITIONAL WATERTIGHT CORROSION RESISTANT METAL FAN BELOW CONDENSATE PRODUCING EQUIPMENT INSTALLED IN ATTIC. (CMC 312.2)


WHOLE BUILDING VENTILATION:

1. SHALL MEET THE REQUIRED WHOLE BUILDING VENTILATION AIRFLOW RATE OF 50 CFM.
2. WHOLE BUILDING EXHAUST FAN SHALL HAVE A SOUND RATING OF ONE SONOR OR LESS AT THE REQUIRED AIRFLOW RATE.
3. WHOLE-BUILDING EXHAUST FAN CONTROL(S) SHALL BE LABELED AS TO FUNCTION AND IMPORTANCE FOR SYSTEM COMPLYING WITH THE PRESCRIPTIVE VENTILATION SYSTEM INSPECTION REQUIREMENTS.
4. WHOLE-BUILDING EXHAUST FAN SHALL RATED TO PROVIDE AT LEAST THE MINIMUM VENTILATION RATE AT A MINIMUM STATIC PRESSURE OF 0.25" W.C.
5. WHOLE BUILDING VENTILATION DUCT SHALL BE MINIMUM OF 4" DIA.3. A ED AT THE ENTRANCE TO THE PASSAGEWAY.

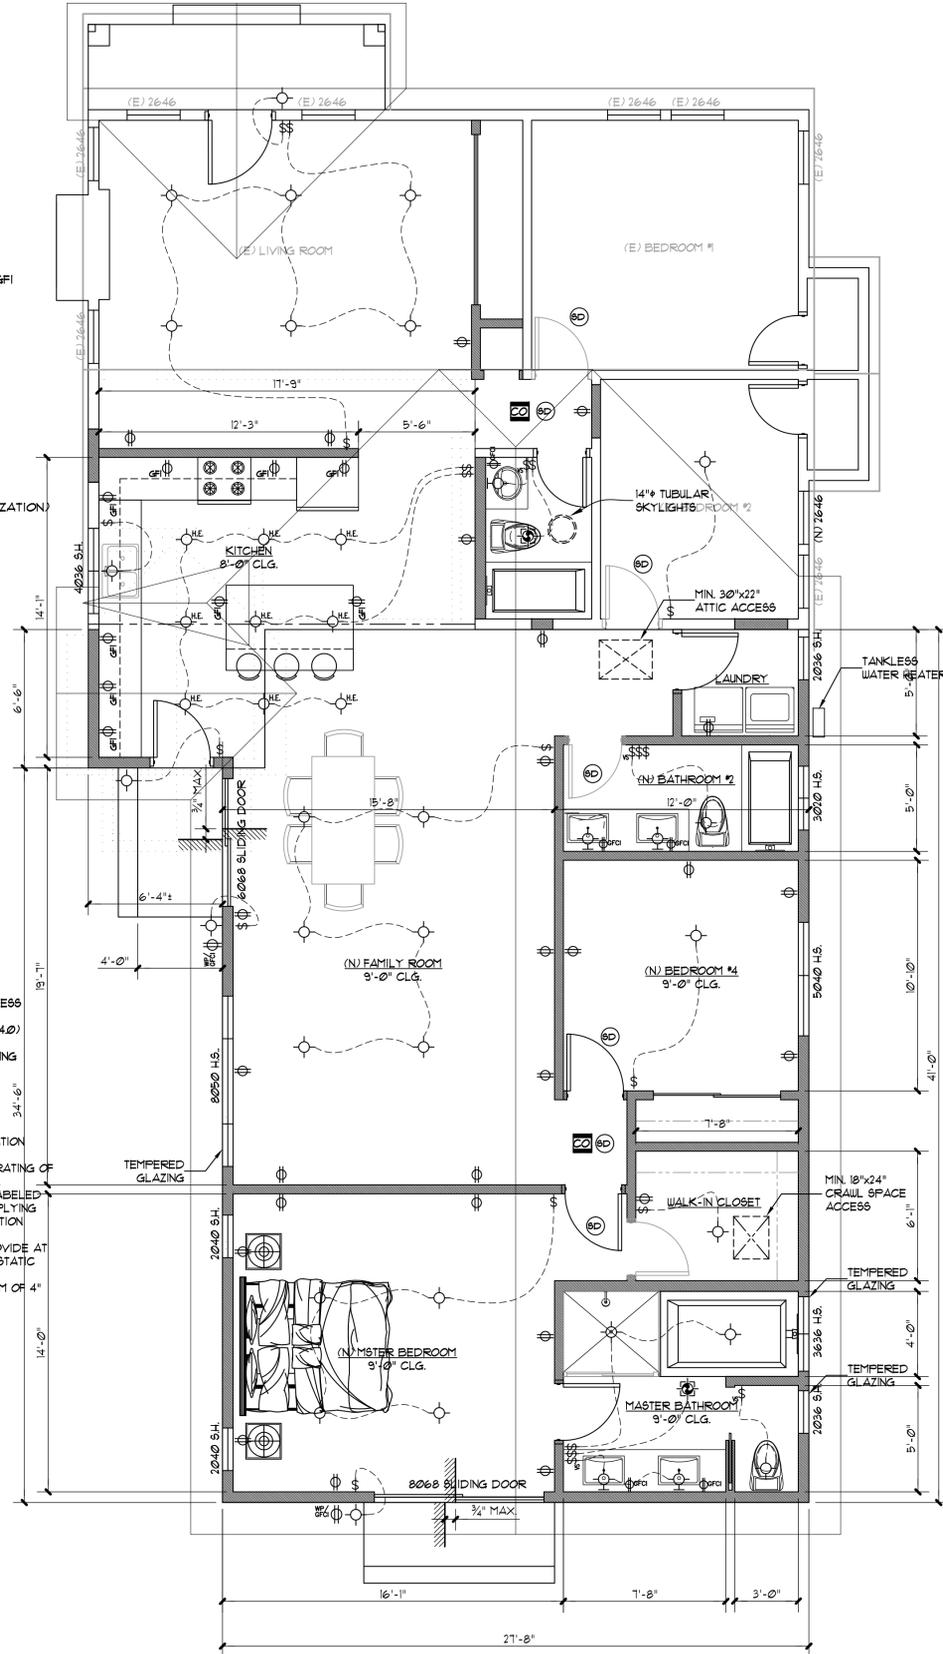


PROPOSED FLOOR PLAN
SCALE: 1/4"=1'-0"

1

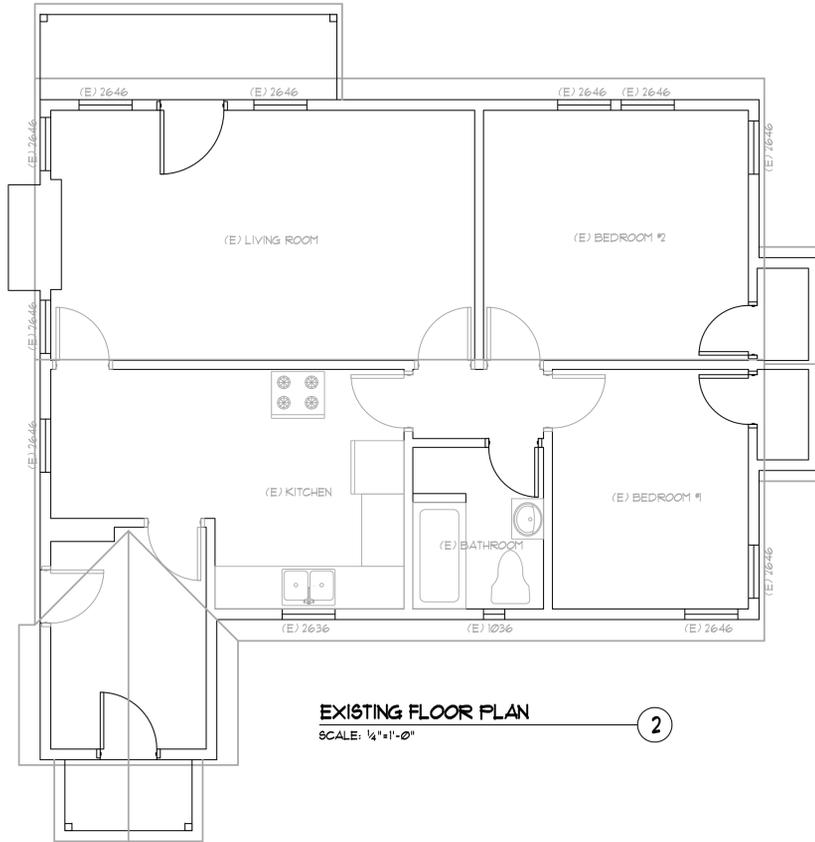

EXISTING FLOOR PLAN
SCALE: 1/4"=1'-0"

2

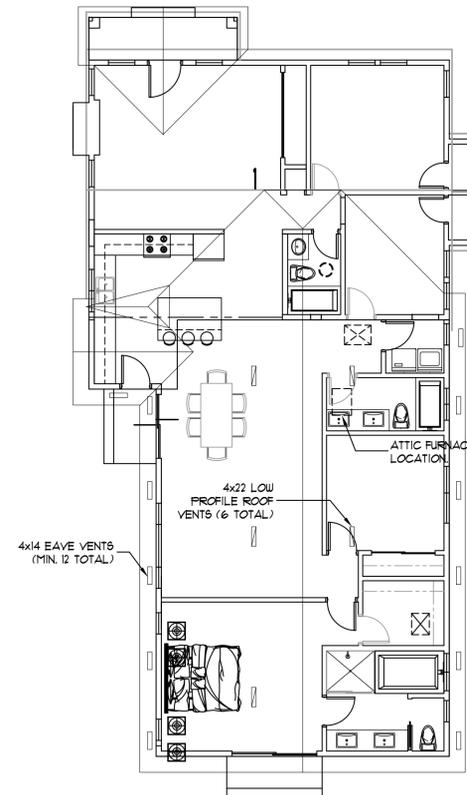

PROPOSED ROOF PLAN
SCALE: 1/8"=1'-0"

3

BATHROOM REMODEL NOTES:

1. PROVIDE WATER PROOFED MATERIAL AT SHOWER WALLS.
2. ALL RECEPTACLES SHALL BE GFCI PROTECTED AND CONNECTED TO A DEDICATED 20 AMP'S CIRCUIT.
3. ALL LIGHTING SHALL BE HIGH EFFICIENCY. AT LEAST ONE LIGHTING SWITCH IN EACH BATHROOM SHALL BE CONTROLLED BY VACANCY SENSORS.
4. PROVIDE AGGREGATE GLAZING AREA IN WINDOWS OF NOT LESS THAN 3 SQUARE FEET (1/2 OPENABLE) OR PROVIDE MECHANICAL VENTILATION SHOWER SHALL BE A MINIMUM 1024 SQUARE INCHES AND CAPABLE OF ENCOMPASSING 30 INCHES DIAMETER.
5. WATER CLOSETS (MAX 125 GPM) SHALL BE CLEAR 30 INCHES WIDE (15 INCHES ON CENTER) AND 24 INCHES IN FRONT.
6. SHOWER HEAD (MAX 2.0 GPM) & LAVATORY FAUCETS (MAX 1.2 GPM).
7. PROVIDE INDIVIDUAL PRESSURE BALANCE, THERMOSTATIC, OR COMBINATION PRESSURE/BALANCE THERMOSTATIC MIXING VALVES.
8. WATER RESISTANT GYPSUM BACKING BOARD SHALL NOT BE USED WHERE THERE WILL BE DIRECT EXPOSURE TO WATER, OR IN AREA SUBJECT TO CONTINUOUS HIGH HUMIDITY. FIBER-CEMENT, FIBER-MAT REINFORCED CEMENT, GLASS MAT GYPSUM BACKERS AND FIBER-REINFORCED GYPSUM BACKER SHALL BE USED AS BACKERS FOR WALL TILE IN TUB AND SHOWER AREAS AND WALL PANELS IN SHOWER AREAS.

ELECTRICAL NOTES:

1. ALL INSTALLED LUMINAIRE SHALL BE HIGH EFFICACY.
2. IN BATHROOMS, GARAGES, LAUNDRY ROOMS AND UTILITY ROOMS, AT LEAST ONE LUMINAIRE IN EACH OF THESE SPACES SHALL BE CONTROLLED BY A VACANCY SENSOR.
3. RECESSED LUMINAIRE IN CEILING SHALL COMPLY WITH THE FOLLOWING REQUIREMENTS:
 - a. BE LISTED FOR ZERO CLEARANCE INSULATION CONTACT.
 - b. HAVE A LABEL THAT CERTIFIES THE LUMINAIRE IS AIRTIGHT.
 - c. BE SEALED WITH A GASKET OR CAULK BETWEEN THE LUMINAIRE HOUSING AND CEILING.
 - d. FOR LUMINAIRE WITH HARDWIRED BALLASTS OR DRIVERS, ALLOW BALLAST OR DRIVER MAINTENANCE AND REPLACEMENT TO BE READILY ACCESSIBLE.
 - e. SHALL NOT HAVE SCREW BASED SOCKETS.
 - f. SHALL CONTAIN LIGHT SOURCES THAT COMPLY WITH REFERENCES JOINT APPENDIX JAB AND ARE MARKED "JAB-2016-E".
 - g. DIMMERS OR VACANCY SENSORS SHALL CONTROL ALL LUMINAIRE REQUIRED TO HAVE LIGHT SOURCES COMPLIANT WITH REFERENCE JOINT APPENDIX JAB.
4. EXCEPTION: CLOSET LESS THAN 10 SQ. FEET AND HALLWAYS.
5. OUTDOOR LIGHTING WHICH IS PERMANENTLY MOUNTED TO A DWELLING OR OTHER BUILDINGS ON THE SAME PARCEL SHALL BE HIGH EFFICACY AND BE CONTROLLED BY A MANUAL ON OFF SWITCH WITH A MOTION SENSOR AND PHOTOCONTROL, OR A TIME SWITCH AND PHOTOCONTROL, OR A ASTRONOMICAL TIME CLOCK PROGRAMMED TO TURN OFF THE LIGHTING DURING DAYLIGHT HOURS.
6. PROVIDE SEPARATE DEDICATED 20 AMP CIRCUITS FOR GARBAGE DISPOSAL UNIT AND DISHWASHER AT KITCHEN.

KITCHEN REMODEL NOTES:

1. KITCHEN DOORS LEADING FROM GARAGE SHALL BE 1 3/4" SOLID WOOD OR STEEL OR 20 MINUTE RATED, SELF-CLOSING, TIGHT FITTING, SELF-LATCHING.
2. COUNTER RECEPTACLES SHALL BE GFCI PROTECTION, LOCATED AT NO POINT IS MORE THAN 24 INCHES AWAY FROM A RECEPTACLE.
3. RECEPTACLE REQUIRED AT ISLANDS AND PENINSULAS, 24"x12" OR LARGER.
4. MINIMUM OF 50% OF TOTAL LIGHTING WATTAGES SHALL BE HIGH EFFICACY.
5. PROVIDE MINIMUM 30 INCHES CLEARANCE REQUIRED ABOVE KITCHEN HOOD, EXCEPT WHERE 24 INCHES IS ALLOWED PER CODE OR MANUFACTURER'S SPECIFICATION.
6. DOMESTIC DISHWASHING MACHINE SHALL NOT BE CONNECTED DIRECTLY TO A DRAINAGE OR FOOD WASTE DISPOSER WITH A LISTED AIR GAP.

KEYNOTES

1. PROVIDE 3/8" TYPE "X" ONE HOUR RATED GYPSUM BOARD AT WALL & CEILING OF ENCLOSED SPACE UNDER STAIRWAY W/ REQUIRED FIRE BLOCKING.
2. ALL 120-VOLT, SINGLE PHASE, 15 AND 20 AMPERE BRANCH CIRCUITS SUPPLYING OUTLETS INSTALLED IN DWELLING UNIT FAMILY ROOMS, DINING ROOMS, LIVING ROOMS, PARLORS, LIBRARIES, DEN'S, BEDROOMS, SUNROOMS, RECREATION ROOMS, CLOSETS, HALLWAYS, KITCHEN OR SIMILAR SPACES SHALL BE PROTECTED BY A LISTED ARC-FAULT CIRCUIT INTERRUPTER.
3. SMOKE DETECTOR SHALL BE HARDWIRED TO 110V W/ BATTERY BACKUP AND SHALL BE INTERCONNECTED. CARBON MONOXIDE ALARMS SHALL BE INTERCONNECTED AND EQUIPPED WITH A BATTERY BACKUP.
4. NEW INTERIOR STAIRS:
 - A. THE MAXIMUM RISER HEIGHT SHALL BE 7 1/2 INCHES. (CRC R311.4.1)
 - B. THE MINIMUM TREAD DEPTH SHALL BE 10 INCHES. (CRC R311.4.2)
 - C. A NOSING NOT LESS THAN 3/4" INCH BUT NOT MORE THAN 1/4 INCHES SHALL BE PROVIDED ON STAIRWAYS WHERE THE TREAD DEPTH IS LESS THAN 11 INCHES. (CRC R311.4.3)
 - D. THE GRAB RAIL TREAD HEIGHT, DEPTH OR NOSING WITHIN AN FLIGHT OF STAIRS SHALL NOT EXCEED THE SMALLEST BY MORE THAN 3/8" INCHES. (CRC R311.4.4)
5. WATER HEATER SHALL HAVE SUFFICIENT CAPACITY TO PROVIDE A "FIRST HOUR RATING". THE FIRST HOUR RATING IS SHOWN ON THE "ENERGY GUIDE" LABEL ATTACHED TO THE WATER HEATER.
6. COMBUSTION AIR OPENINGS: PROVIDE TWO PERMANENT OPENINGS, ONE COMMENCING WITHIN TWELVE INCHES OF THE TOP AND ONE COMMENCING WITHIN TWELVE INCHES OF THE BOTTOM OF THE ENCLOSURE WHERE COMMUNICATING WITHIN THE OUTDOORS THROUGH HORIZONTAL DUCTS. EACH OPENING SHALL HAVE A MINIMUM FREE AREA OF 1 IN 2 / 2000 BTU/H OF TOTAL INPUT RATING OF ALL EQUIPMENT IN THE ENCLOSURE.
7. PROVIDE SEISMIC STRAPPING FOR THE WATER HEATER. STRAPPING SHALL BE AT POINTS WITHIN THE UPPER 1/3 AND LOWER 1/3 OF ITS VERTICAL DIMENSIONS. AT THE LOWER POINT, A MINIMUM DISTANCE OF 4" SHALL BE MAINTAINED ABOVE THE CONTROLS WITH THE STRAPPING.
8. SHOWER COMPARTMENTS AND WALLS ABOVE BATHTUBS WITH INSTALLED SHOWER HEADS SHALL BE FINISHED WITH A NONABSORBENT SURFACE TO A HEIGHT NOT LESS THAN 6 FEET ABOVE THE FLOOR PER CRC R307.2.
9. DRYER VENT TO OUTSIDE SHALL HAVE A MAXIMUM LENGTH OF 14' EQUIPPED WITH A BACK DRAFT DAMPER INCLUDING TWO 90 DEGREE ELBOWS AND A MINIMUM DIAMETER OF 4". THE VENT DISCHARGE LOCATION SHALL BE A MINIMUM 3 FEET AWAY FROM ANY OPENING INTO THE BUILDING PER CMC 504.3.1
10. 1 HR-RATED FLOOR-CEILING ASSEMBLY WITH MINIMUM STC RATING OF 45. SEE DETAIL 5/A6.
11. BUILT-IN MEDICINE CABINETS PER OWNER'S SPECIFICATION
12. PROVIDE A MINIMUM 100 SQ. INCHES OPENING AT CLOSET DOOR.

DESIGNER/ENGINEER:
JOSEPH XU
XU ENGINEERING
339 BARTON DRIVE
FREMONT, CA 94536
P. 510.676.2733
F. 510.794.2930
xueengineering@yahoo.com



Project Title:
RESIDENTIAL ADDITION & REMODEL
1286 MUNRO AVENUE
CAMPBELL, CA 95008

Sheet Title:
EXISTING & PROPOSED FLOOR PLANS

Revision No.:	Date:
PERMIT	06/16/2017
PLAN CHECK REV. 1	08/30/2017

Date: 03/20/2017


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Sheet No:

A2


Project No:
1286



PROPOSED FRONT ELEVATION
 SCALE: 1/4"=1'-0"

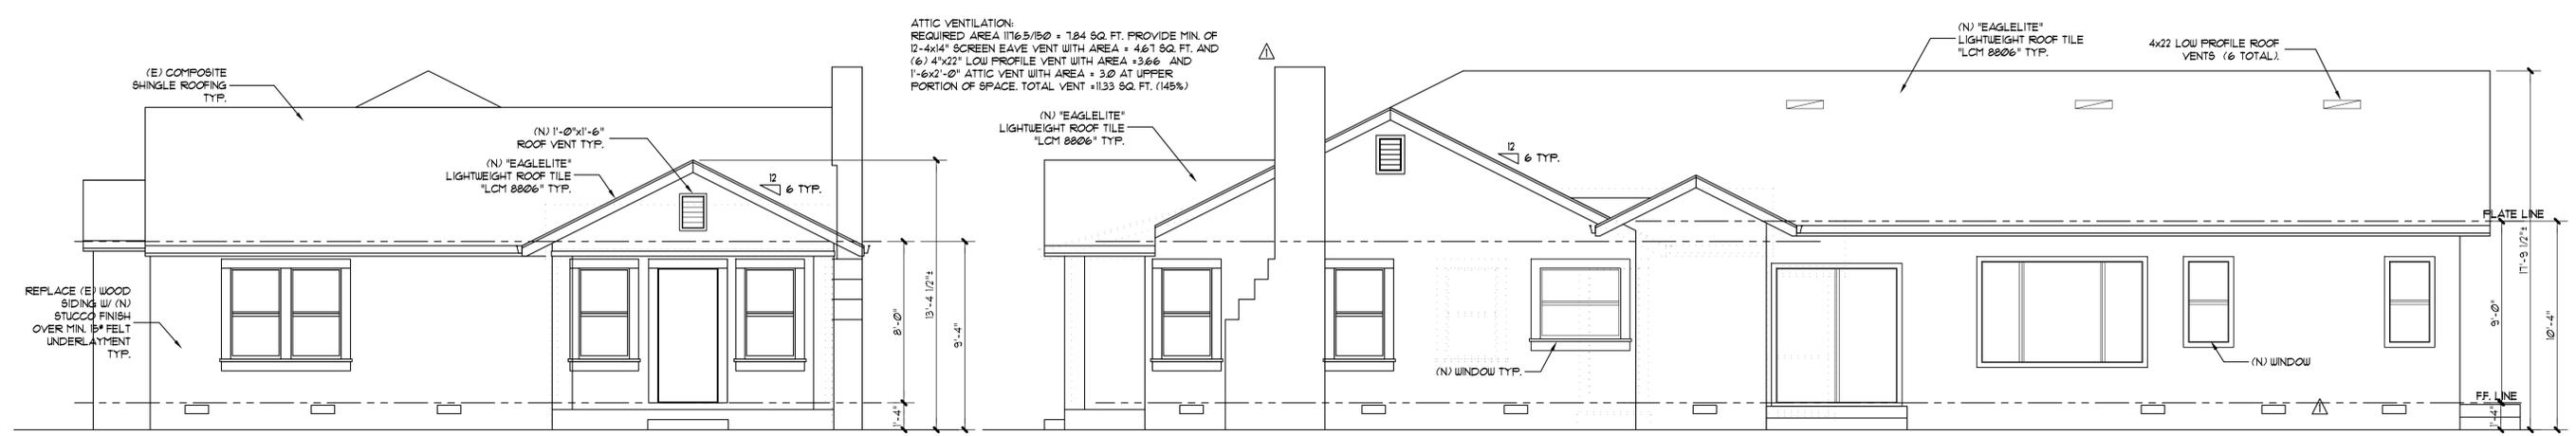PROPOSED RIGHT ELEVATION
 SCALE: 1/4"=1'-0"



NOTE:
 1. ALL WINDOWS & TRIMERS SHALL MATCH & ALIGN WITH EXISTING.
 2. EXTERIOR FINISH: 3/8" STUCCO TO MATCH (E) OVER 2 LAYERS OF GRADE 'D' BUILDING PAPER (MIN. 1/8" FELT) OVER MIN. 1/2" CDX FLYWOOD, ARYLIC FINISH COATE
 3. 1/2" FASCIA G&M. GUTTER TO MATCH EXISTING, WITH BRACKETS @ 48" O.C. W/ PAINTED DOWNSPOUTS, TO MATCH EXISTING, TIED TO PERIMETER DRAIN SYSTEM. SEE GRADING AND DRAINAGE PLAN. CONTRACTOR TO VERIFY DOWNSPOUT LOCATIONS.
 4. G&M FOUNDATION VENT-SCREENED, VERIFY SIZE AND NET FREE AREA WITH FOUNDATION VENTILATION CALCULATIONS.
 5. DUAL GLAZED VINYL FRAME WINDOWS TYPICAL BY 'MILGARD' OR APPROVED EQUAL.

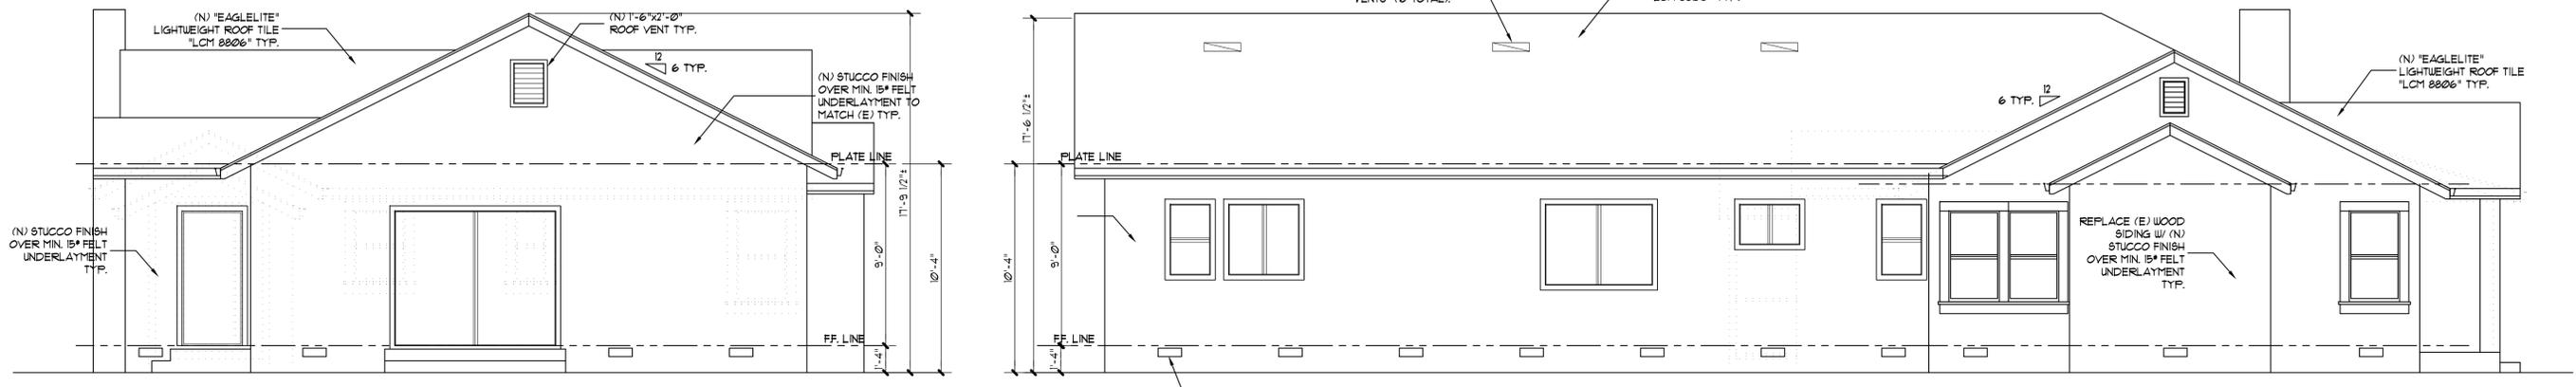

PROPOSED REAR ELEVATION
 SCALE: 1/4"=1'-0"

PROPOSED LEFT ELEVATION
 SCALE: 1/4"=1'-0"






FOUNDATION VENTILATION:
 REQUIRED AREA $1176.5/150 = 7.84$ SQ. FT. PROVIDE AREA 9.32 SQ. FT. (126%)

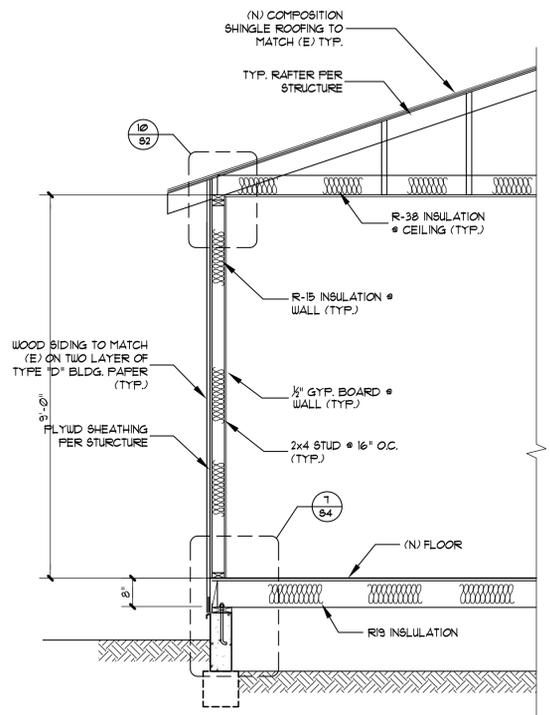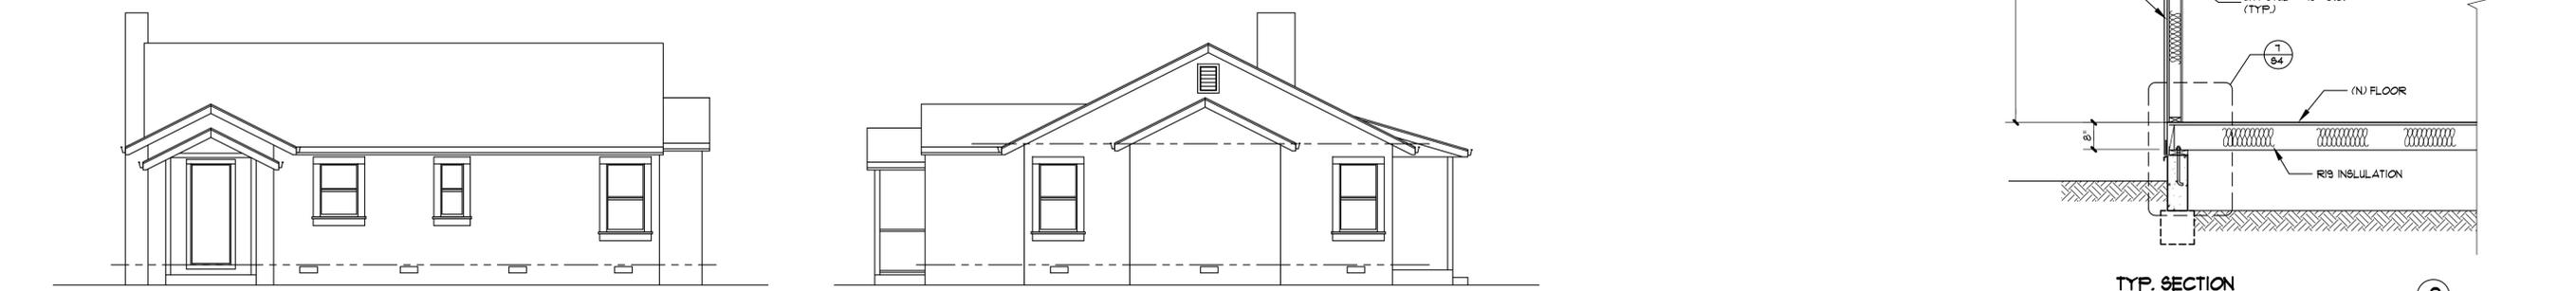


TYP. SECTION
 SCALE: 1/2"=1'-0"

CALIFORNIA GREEN BUILDING STANDARD CODE NOTES:

1. THE EFFECTIVE FLUSH VOLUME OF ALL WATER CLOSETS SHALL NOT EXCEED 128 GALLONS PER FLUSH.
2. SHOWER HEADS SHALL HAVE A MAXIMUM FLOW RATE OF NOT MORE THAN 2.0 GALLONS PER MINUTES AT 80 PSI.
3. THE MAXIMUM FLOW RATE OF RESIDENTIAL LAVATORY FAUCETS SHALL NOT EXCEED 1.2 GALLONS PER MINUTE AT 60 PSI AND SHALL NOT BE LESS THAN 0.8 GALLONS PER MINUTES AT 20 PSI.
4. THE MAXIMUM FLOW RATE OF KITCHEN FAUCETS SHALL NOT EXCEED 1.8 GALLONS PER MINUTES AT 60 PSI. KITCHEN FAUCETS MAY TEMPORARILY INCREASE THE FLOW RATE ABOVE THE MAXIMUM RATE, BUT NOT TO EXCEED 2.2 GALLON PER MINUTE AT 60 PSI, AND MUST DEFAULT TO A MAXIMUM FLOW RATE OF 1.8 GALLONS PER MINUTE AT 60 PSI.
5. AT THE TIME OF ROUGH INSTALLATION, DURING STORAGE ON THE CONSTRUCTION SITE AND UNTIL FINAL STARTUP OF THE HEATING, COOLING, AND VENTILATION EQUIPMENT, ALL DUCT AND OTHER RELATED AIR DISTRIBUTION COMPONENT OPENINGS SHALL BE COVERED WITH TAPE, PLASTIC, SHEET METAL OR OTHER METHODS TO REDUCE THE AMOUNT OF WATER, DUST AND DEBRIS, WHICH MAY ENTER THE SYSTEM.
6. ADHESIVES, SEALANTS AND CAULKS SHALL MEET THE APPLICABLE STANDARDS OF CGBSC 4.504.2.1 AND TABLES 4.504.1 AND 4.504.2 FOR VOC LIMITS AND CONTENT PROHIBITIONS.
7. PAINTS AND COATINGS SHALL MEET THE APPLICABLE STANDARDS OF CGBSC 4.504.2.2 AND TABLE 4.504.3 FOR VOC LIMITS.
8. AEROSOL PAINTS AND COATING SHALL MEET THE APPLICABLE STANDARDS OF CGBSC 4.504.2.3.
9. CARPET SYSTEMS SHALL MEET THE APPLICABLE STANDARD OF CGBSC 4.504.3 INCLUDING CGBSC 4.504.3.1 FOR CARPET CUSHIONS AND CGBSC 4.504.3 CARPET ADHESIVES.
10. RESILIENT FLOORING SHALL MEET THE APPLICABLE STANDARDS OF CGBSC 4.504.4.
11. COMPOSITE WOOD PRODUCTS, INCLUDING HARDWOOD PLYWOOD, PARTICLEBOARD AND MEDIUM DENSITY FIBER BOARD, SHALL MEET THE APPLICABLE STANDARD OF CGBSC 4.504.5 AND TABLE 4.505.5 FOR LIMITS OF FORMALDEHYDE EMISSION.
12. BATHROOM EXHAUST FAN SHALL BE PROVIDED HAVING A MINIMUM CAPACITY OF 50 CFM, A SOUND RATING OF 3 SONES OR LESS.
13. KITCHEN EXHAUST FAN SHALL BE PROVIDED HAVING A MINIMUM CAPACITY OF 100 CFM AND A SOUND RATING OF 3 SONES OR LESS.
14. WHOLE BUILDING VENTILATION SHALL BE PROVIDED. FAN CAPACITY SHALL BE DEMONSTRATED TO COMPLY BASE ON EQUATION 4.1a OR 4.2 PER ASHRAE 62.2. FAN INTENDED FOR CONTINUOUS OPERATION SHALL HAVE A SOUND RATING NOT EXCEEDING 1 SONE.
15. SUBMIT CONSTRUCTION WASTE MANAGEMENT PLAN PER CALGREEN SECTION 4.408.2 (OR IN ACCORDANCE WITH THE LOCAL ORDINANCE). DIVERT A MINIMUM OF 65% OF THE CONSTRUCTION WASTE GENERATED AT THE SITE TO RECYCLE OR SALVAGE PER SECTION 4.408.1.
16. PROVIDE A COPY OF THE OPERATION AND MAINTENANCE MANUAL TO THE BUILDING OCCUPANT OR OWNER ADDRESSING ITEMS 1 THROUGH 10 IN SECTION 4.410.1.
17. DUCT SYSTEM ARE SIZED, DESIGNED, AND EQUIPMENT IS SELECTED PER SECTION 4.501.2. HVAC SYSTEM INSTALLER MUST BE TRAINED AND CERTIFIED AND SPECIAL INSPECTORS EMPLOYED BY THE ENFORCING AGENCY MUST BE QUALIFIED.
18. EACH BATHROOM SHALL BE MECHANICAL VENTILATED WITH AN ENERGY STAR EXHAUST FAN, AND FAN MUST BE CONTROLLED BY A HUMIDITY CONTROL.
19. PROTECT ANNULAR SPACES AROUND PIPES, ELECTRICAL CABLES, CONDUITS OR OTHER OPENINGS AT EXTERIOR WALLS AGAINST THE PASSAGE OF RODENTS.
20. INSTALL CAPILLARY BREAK AND VAPOR RETARDER AT SLAB ON GRADE FOUNDATIONS.
21. CHECK MOISTURE CONTENT OF BUILDING MATERIALS USED IN WALL AND FLOOR FRAMING BEFORE ENCLOSURE.
22. WALL AND FLOOR FRAMING SHALL NOT BE ENCLOSED WHEN THE FRAMING MEMBERS EXCEED 19 PERCENT MOISTURE CONTENT. MOISTURE CONTENT SHALL BE VERIFY BY MEANS OF MOISTURE READINGS USING A MOISTURE METER.

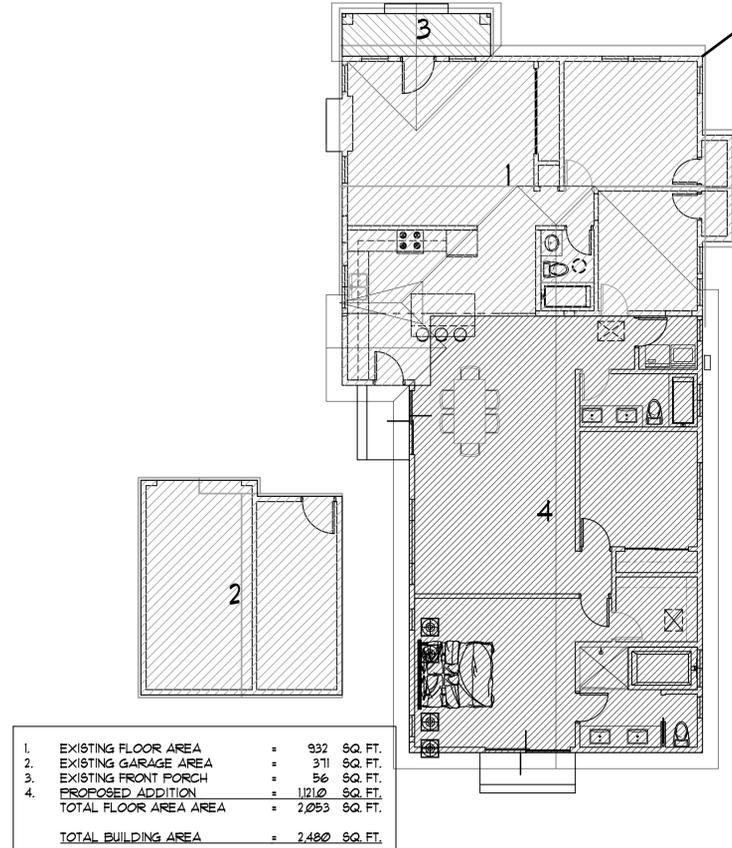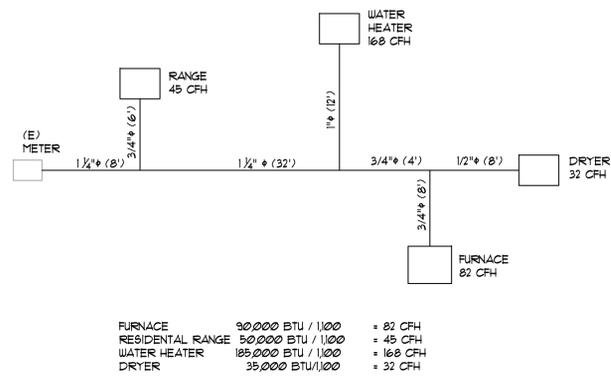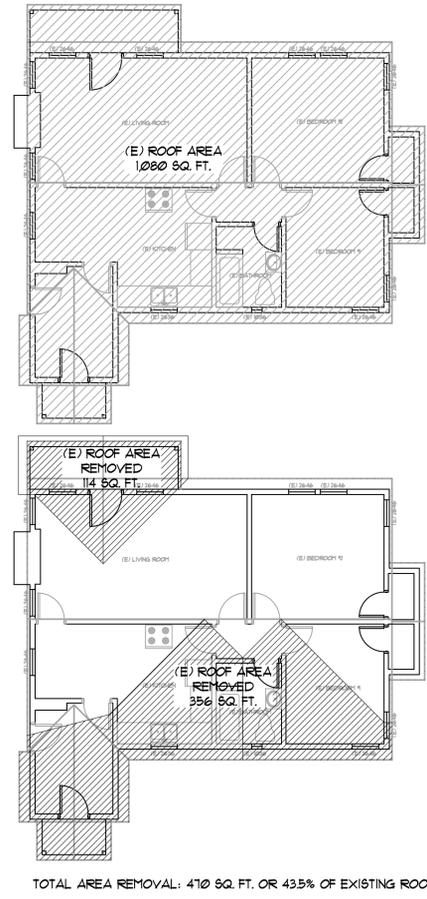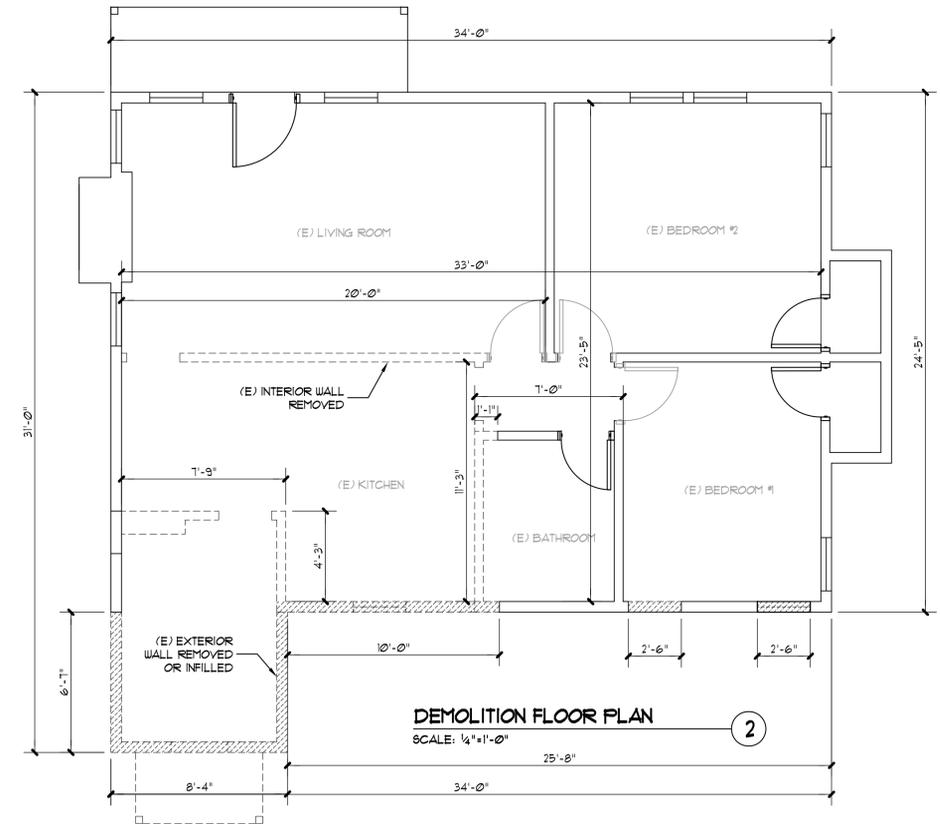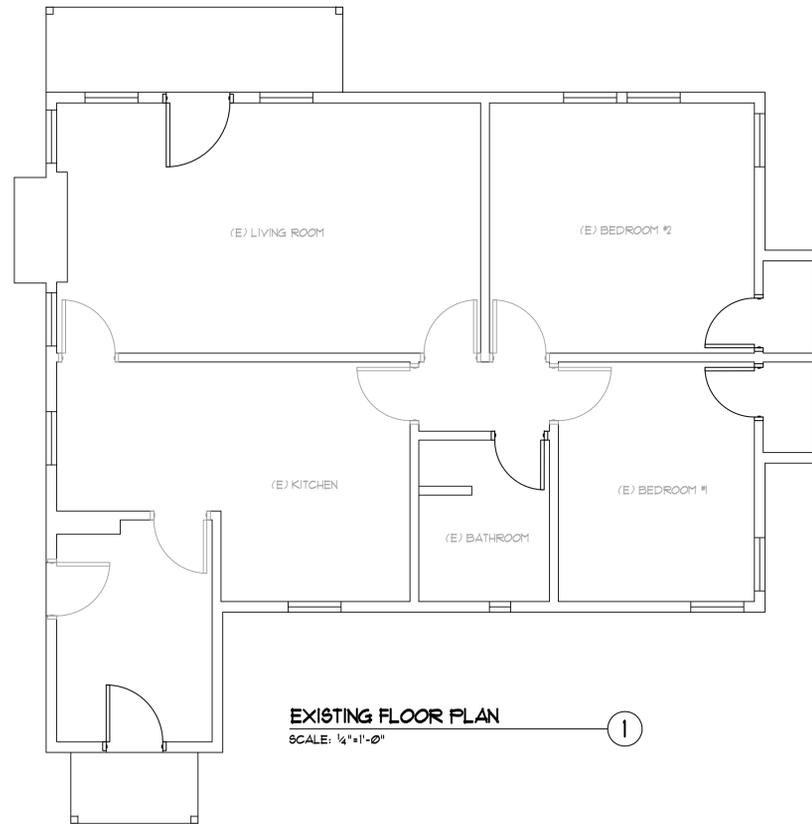

DESIGNER/ENGINEER:
JOSEPH XU
 XU ENGINEERING
 339 BARTON DRIVE
 FREMONT, CA 94536
 P. 510.676.2733
 F. 510.794.2830
 xuengineering@yahoo.com

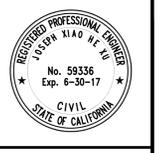

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RESIDENTIAL ADDITION & REMODEL
 1286 MUNRO AVENUE
 CAMPBELL, CA 95008

Sheet Title:
CAL GREEN NOTES AND DETAILS

Revision No.:	Date:
PERMIT	06/16/2017
PLAN CHECK REV. 1	08/30/2017
Date:	03/20/2017
Drawn by:	
Checked by:	
Sheet No:	A4
Project No:	1286

EXTERIOR FINISHES MATERIAL & COLOR TABLE

MATERIAL BOARD NO.	BUILDING AREA	MATERIAL	COLORS	MANUFACTURE
3	ROOFING	LIGHTWEIGHT TILE	TAN	EAGLELITE
<div style="display: flex; justify-content: center; align-items: center; gap: 10px;">  </div> <div style="display: flex; justify-content: center; align-items: center; gap: 10px; margin-top: 5px;"> LCC 8806 Tucson Blend - Tan, Terracotta, Mauve Blend  Ref: .20 Emi: .88 SRI: 18 A.SRI: 18 CRRC: 0918-0085  </div>				
4				

EXTERIOR FINISHES MATERIAL & COLOR TABLE

MATERIAL BOARD NO.	BUILDING AREA	MATERIAL	COLORS	MANUFACTURE
1	WALL	STUCCO	WISE OWL	KELLY-MOOR
		 <p>The screenshot shows the Kelly-Moore Paints myCOLORSTUDIO interface. At the top, the logo 'KELLY-MOORE PAINTS' and 'myCOLORSTUDIO™' are visible. Below the search bar, the selected color is 'Wise Owl' with a small number '42'. A large rectangular swatch of the color is displayed. To the right of the swatch are social media icons for Facebook, Twitter, and Pinterest. At the bottom right of the swatch area is a blue button labeled 'ADD TO CURRENT'.</p>		
2	TRIMS	STUCCO	SWISS COFFEE	KELLY-MOOR
		 <p>The screenshot shows the Kelly-Moore Paints myCOLORSTUDIO interface. At the top, the logo 'KELLY-MOORE PAINTS' and 'myCOLORSTUDIO™' are visible. Below the search bar, the selected color is 'Swiss Coffee' with a small number '25'. A large rectangular swatch of the color is displayed. To the right of the swatch are social media icons for Facebook, Twitter, and Pinterest. At the bottom right of the swatch area is a blue button labeled 'ADD TO CURRENT'.</p>		